

Staff Report Variance Case BOA-23654

Hearing Date: March 12, 2024 **Prepared by:** Sean Wallace

swallace@cityoftulsa.org

918-596-7585

Owner and Applicant Information

Applicant: Roger McKee

Property Owner: Clifton Lewis III & Rafaela Souza


Property Location

2736 S. Victor Ave E.

Tract Size: ±.4 acres

Location within the City of Tulsa

(shown with City Council districts)

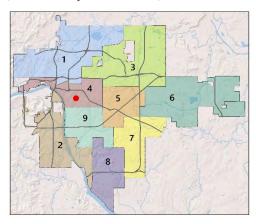

Elected Representatives

City Council: District 4, Laura Bellis.

County Commission: District 2, Karen Keith.

Public Notice Required

Newspaper Notice – min. 10 days in advance Mailed Notice to 300' radius – min. 10 days in advance

Request Summary

Variance to allow a detached Accessory Dwelling Unit to exceed one story or 18 feet in height and to exceed 10 feet in height to the top of the top plate in the rear setback (Section 90.090-C); Variance to allow the floor area of detached accessory buildings to exceed 750 square feet or 40% of the floor area of the principal residential structure (Section 45.030-B, 45.031-D. 6.a); Special Exception to allow an Accessory Dwelling Unit in an RS-1 District (45.031-D).

Zoning

Zoning District: RS-1 Zoning Overlays: N/A

Comprehensive Plan Considerations

Land Use

Land Use Plan: Neighborhood

Small Area Plans: None

Development Era: Early Automobile

Transportation

Major Street & Highway Plan: N/A

planitulsa Street Type: N/A

Transit: N/A

Existing Bike/Ped Facilities: None

Planned Bike/Ped Facilities: An on-street signed bike route is

recommended on S Utica Ave in the Go Plan.

Environment

Flood Area: N/A

Tree Canopy Coverage: 30-50%

Parks & Open Space: N/A


BOA-23654 Staff Report March 12, 2024

Staff Analysis

The applicant is requesting a Variance to allow a detached Accessory Dwelling Unit to exceed one story or 18 feet in height and to exceed 10 feet in height to the top of the top plate in the rear setback (Section 90.090-C); Variance to allow the floor area of detached accessory buildings to exceed 750 square feet or 40% of the floor area of the principal residential structure (Section 45.030-B); Special Exception to allow an Accessory Dwelling Unit in an RS-1 District (45.031-D).

The site plan shows the proposed structure to have a height of 23'5". The applicant is proposing a 1,635 sq. ft detached accessory building. This exceeds the 750 sq ft or 40% (1,369 sq. ft.) of the floor area of the principal building allowed.

Figure 90-9: Maximum Height of Accessory Buildings, Including Accessory Dwelling Units In Rear Setbacks (RE, RS and RD Districts or RM Zoned Lots Used for Detached Houses or Duplexes)

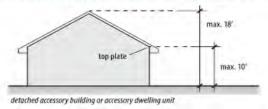

Accessory Dwelling Unit Size

a. RE and RS-1 Districts

In RE and RS-1 districts, the total aggregate floor area of all detached accessory buildings, including accessory dwelling units, may not exceed 750 square feet or 40% of the floor area of the principal residential structure, whichever is greater. [1]

Relevant Case History

None

Statement of Hardship

"1. The property is wedge shaped and the allowable construction area would prevent proper separation from the main structure. 2. There are adjacent properties with similar conditions so we would be keeping the character of the neighborhood. 3. Based on existing structures, lot shape and additional living, is why we are seeking this variance. 4. An elderly parent will be moving in with the homeowners for them to provide aging assistance. The location proposed provides the most adequate solution. 5. We are asking for the minimum relief required to facilitate our client's needs. 6. This proposed variance keeps with the nature and intent of both the zoning code and comprehensive plan."

Comprehensive Plan Considerations

Land Use Plan

The subject property is designated as Neighborhood. **Neighborhoods** are mostly residential uses, which includes detached, missing middle, and multi-dwelling unit housing types. Churches, schools, and other low intensity uses that support residents' daily needs are often acceptable, particularly for properties abutting Multiple Use, Local Center, or Regional Center land use areas. Multi-dwelling unit housing that takes access off an arterial is considered Multiple Use, Local Center, or Regional Center. If a multi-dwelling unit housing property takes access from a lower-order street separated from the arterial, then it would be considered Neighborhood.

Surrounding Properties:

<u>Location</u>	Existing Zoning/Overlay	Existing Land Use Designation	<u>Existing Use</u>
North	RE	Neighborhood	Residential
East	RE	Neighborhood	Residential
South	RS-1	Neighborhood	Residential
West	RS-1	Neighborhood	Residential

Small Area Plans

The subject property is not within a Small Area Plan.

Development Era

The subject property is in an area developed during the Early Automobile Era (1930s-50s), which retained a high degree of the connectivity from neighborhood streets to the arterial network, with mostly commercial, office, industrial, and other active uses along major streets and a mix of housing options and neighborhood-based uses like schools, churches, and libraries in the interior sections. Priorities in these areas include walkability, bikeability, access to public transit, historic preservation, housing type variety, mixed-use development, commercial revitalization, compatibility of scale for neighborhood development, and transitions between commercial corridors and residential areas.

Transportation

Major Street & Highway Plan: N/A

Comprehensive Plan Street Designation: N/A

Transit: N/A

Existing Bike/Ped Facilities: None

Planned Bike/Ped Facilities: An on-street signed route is recommended on S. Utica Ave in the Go Plan.

Arterial Traffic per Lane: 4,688 vehicles per lane on Utica Ave.

Environmental Considerations

Flood Area: The subject property is not in a Flood Area.

<u>Tree Canopy Coverage</u>: Tree canopy in the area is 36%. Significant effort should be given to the preservation of mature stands of trees. Tree canopy removal should be minimized, and replacement of trees that need removing should be encouraged.

Parks & Open Space: N/A

BOA-23654 Staff Report March 12, 2024

Sample Motion

I move to <u>approve or deny</u> a Variance to allow a detached Accessory Dwelling Unit to exceed one story or 18 feet in height and to exceed 10 feet in height to the top of the top plate in the rear setback (Section 90.090-C); Variance to allow the floor area of detached accessory buildings to exceed 750 square feet and 40% of the floor area of the principal residential structure (Section 45.030-B); Special Exception to allow an Accessory Dwelling Unit in an RS-1 District (45.031-D),

•	per the conceptual plan(s) shown on page(s) of the agenda packet.
•	subject to the following conditions (including time limitation, if any):
The	board finds the hardship to be

In granting the Variance, the Board finds that the following facts, favorable to the property owner, have been established:

- a. That the physical surroundings, shape, or topographical conditions of the subject property would result in unnecessary hardships or practical difficulties for the property owner, as distinguished from a mere inconvenience, if the strict letter of the regulations were carried out;
- b. That literal enforcement of the subject zoning code provision is not necessary to achieve the provision's intended purpose;
- c. That the conditions leading to the need of the requested variance are unique to the subject property and not applicable, generally, to other property within the same zoning classification;
- d. That the alleged practical difficulty or unnecessary hardship was not created or self-imposed by the current property owner;
- e. That the variance to be granted is the minimum variance that will afford relief;
- f. That the variance to be granted will not alter the essential character of the neighborhood in which the subject property is located, nor substantially or permanently impair use or development of adjacent property; and
- g. That the variance to be granted will not cause substantial detriment to the public good or impair the purposes, spirit, and intent of this zoning code or the comprehensive plan.

Property Description

PRT LTS 14 & 15 BEG 60S NEC LT 15 TH SW TO PT ON WL LT 15 SE107 NE TO PT ON EL NWLY110 POB BLK 11 FOREST HILLS, City of Tulsa, Tulsa County, State of Oklahoma.


Exhibits

Case map Aerial (small scale) Aerial (large scale) Photos Tulsa Comprehensive Plan Land Use Map BOA-23654 Staff Report March 12, 2024



(Subject property)



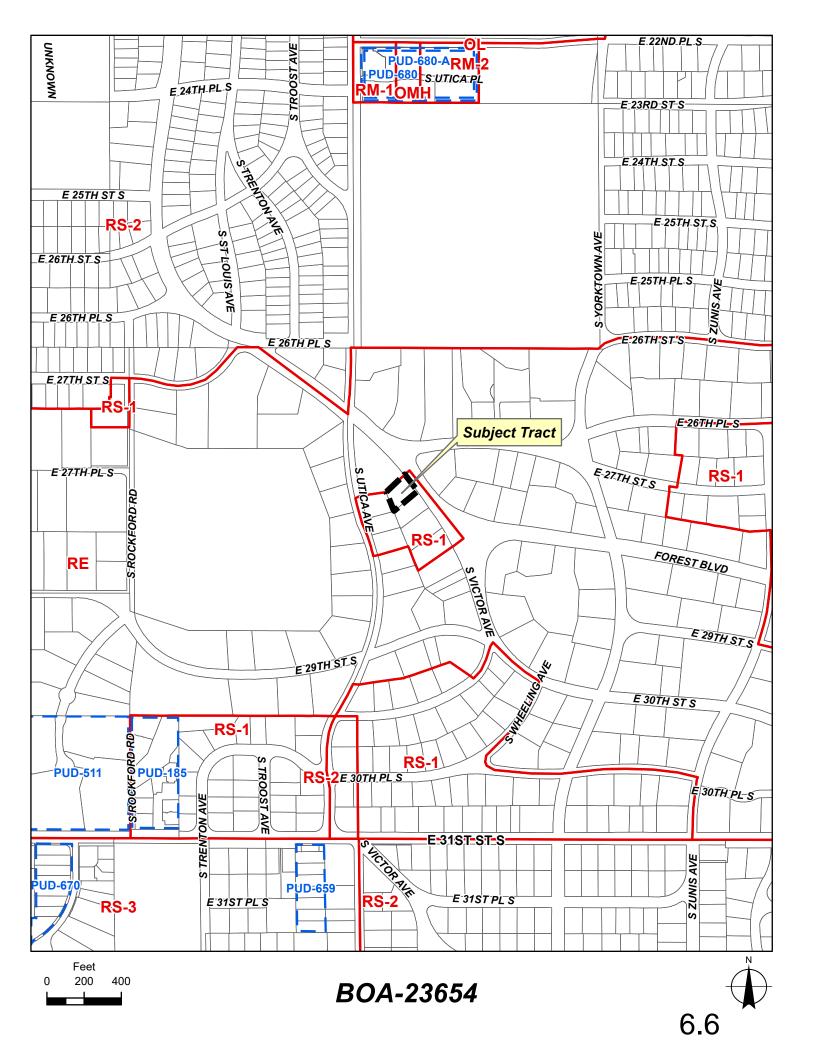




Subject
Tract
0 50 100 200
Feet

BOA-23654


Note: Graphic overlays may not precisely align with physical features on the ground.

Aerial Photo Date: 2021



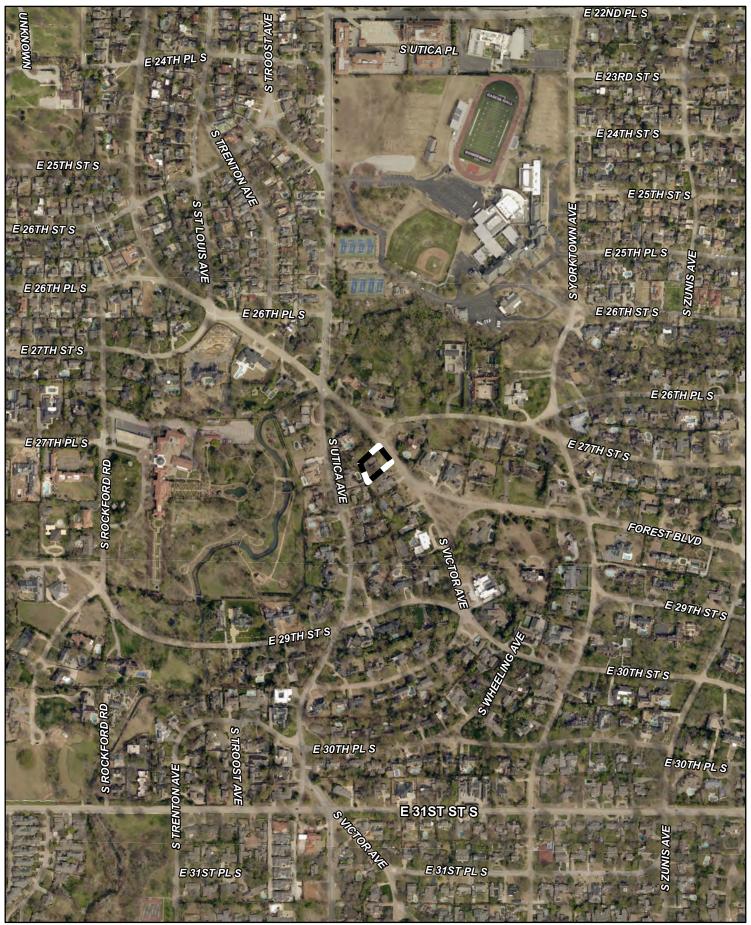


BOA-23654

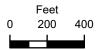



Note: Graphic overlays may not precisely align with physical features on the ground.

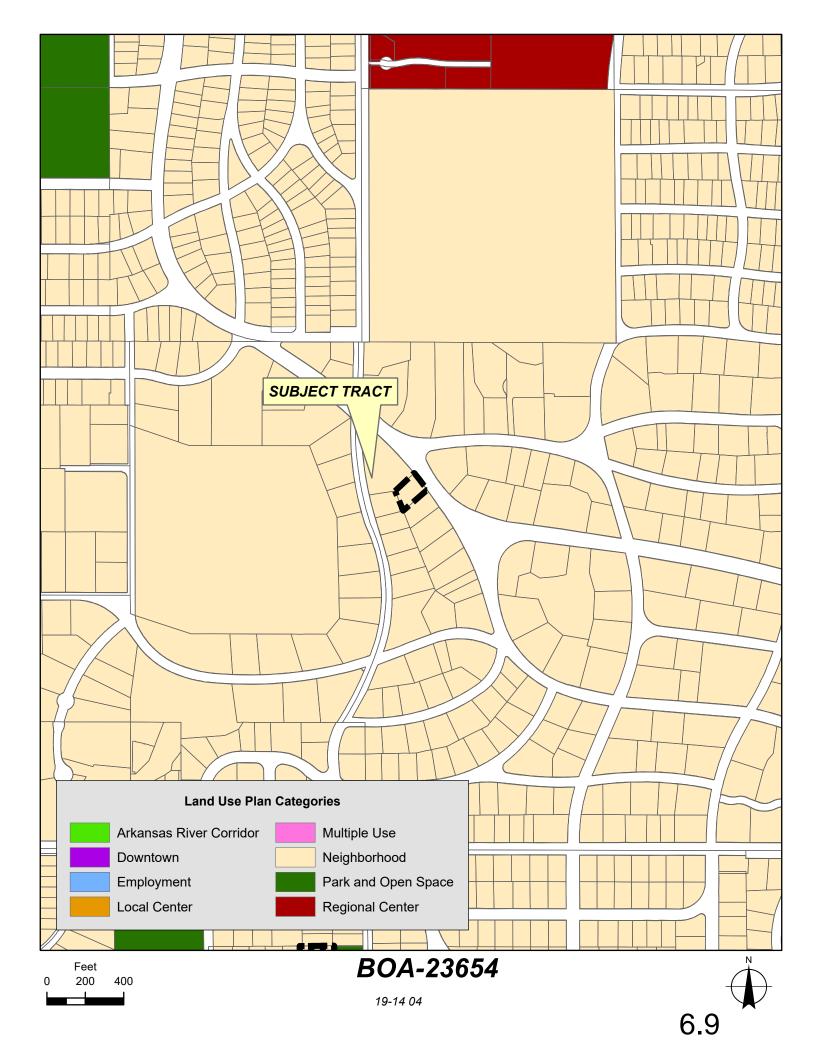

Souza-Lewis Residence Addition

Forest Hills - Part of Lot 14 & 15, Block 11

2736 S. Victor Ave., Tulsa, OK 74114

Job # 23163

CONTRACTOR DIRECTIVES

- ALL WORK SHALL CONFORM TO THE INTERNATIONAL RESIDENTIAL CODE OF REGULATIONS (IRC 2015).
- 2. PRIOR TO BIDDING, THE GENERAL CONTRACTORS SHALL VISIT AND INSPECT THE SITE AND FAMILIARIZE THEMSELVES WITH THE EXISTING CONDITIONS EFFECTING THE NEW WORK. THE GENERAL CONTRACTOR SHALL NOT DISPUTE OR ASSETT THAT THERE IS ANY MISUNDERSTANDING IN REGARD TO LOCATION, EXTENT, NATURE, OR AMOUNT OF WORK TO BE PERFORMED UNDER THIS CONTRACT DUE TO THE CONTRACTOR'S FAILURE TO INSPECT THE SITE.
- 3. THE GENERAL CONTRACTOR AND SUBCONTRACTORS ARE RESPONSIBLE FOR LOCATING AND VERIFYING ALL EXISTING UNDERGROUND UTILITIES IN ALL AREAS OF NEW WORK PRIOR TO COMMENCEMENT OF ANY EXCAVATION. EXISTING UTILITIES SHOWN ON THE DRAWINGS ARE APPROXIMATE ROUTING LOCATIONS AS BEST DETERMINED FROM EXISTING SURVEY, BUT SHOULD NOT BE CONSTRUED TO REPRESENT ALL EXISTING UTILITIES.
- 4. FIELD VERIFY MEANS THE CONTRACTOR IS REQUIRED TO FIELD SURVEY THE NOTED CONDITION AND/OR DIMENSION PRIOR TO CONSTRUCTION OR PREPARATION OF SUBMITTAL SHOP DRAWINGS AND INTEGRATE FIELD SURVEY INFORMATION INTO THE CONSTRUCTION.
- THE ORGANIZATION OF THE DRAWINGS AND SPECIFICATIONS SHALL NOT CONTROL THE CONTRACTOR IN DIVIDING THE WORK AWONG SUBCONTRACTORS OR ESTABLISHING THE EXTENT OF WORK TO BE PERFORMED BY TRADE.
- 6. IN THE EVENT OF A CONFLICT BETWEEN DRAWINGS OR BETWEEN A DRAWING AND SPECIFICATION ITEM, THE DRAWING OR SPECIFICATION ITEM, REQUIRING THE GREATER EXTENT, LARGER NUMBER OR HIGHER QUALITY SHALL GOVERN. IN ADDITION, W DESIGN LLC. MUST BE NOTIFIED OF ANY AND ALL DISCREPANCIES IN DIMENSIONS AND SIZES, PRIOR TO CONSTRUCTION, TO ASSIST IN PROVIDING THE CORRECT INFORMATION.
- 7. ALL ITEMS OF MECHANICAL, ELECTRICAL AND PLUMBING DETAILS AND LOCATIONS MAY NOT NECESSARILY APPEAR ON THE ARCHITECTURAL DRAWINGS. THE DRAWINGS PROVIDED MUST BE REVIEWED WITH THE APPROPRIATE SUBCONTRACTOR PRIOR TO CONSTRUCTION, UNLESS THE ARCHITECT OF RECORD HAS CONSULTED WITH THE APPROPRIATE LICENSED ENGINEER. W DESIGN, LLC. WILL NOT BE RESPONSIBLE FOR FIELD CHANGES DUE TO THE MENTIONED TRADES.
- THE GENERAL CONTRACTOR SHALL BE RESPONSIBLE FOR VERIFYING ALL WINDOW AND DOOR ROUGH OPENINGS PRIOR TO ANY FRAMING OF OPENINGS.
- CHANGES TO THE CITY APPROVED DRAWINGS AND SPECIFICATIONS SHALL BE MADE BY AN ADDENDA OR A CHANGE ORDER, ADDENDA OR CHANGE ORDERS MUST BE APPROVED BY THE ARCHITECT OF RECORD AND THE CITY HOLDING JURISDICTION.
- 10. THE EXISTING GRADE IS A FIELD SURVEY OF EXISTING CONDITIONS PROVIDED BY OWNER. THE ELEVATIONS MEASUREMENTS ARE ONLY APPROXIMATE AND NOT 100% ACCURATE. CONTRACTOR SHALL FIELD VERIFY ALL EXISTING CONDITIONS AND COORDINATE ALL NECESSARY ADJUSTMENTS WITH OWNER.

W DESIGN, LLC.

RESERVES THE COMMONLAW COPYRIGHT AND OTHER PROPERTY RIGHTS IN THESE PLANS. THESE PLANS AND DRAWINGS ARE NOT TO BE REPRODUCED, CHANGED OR COPIED IN ANY FORM OR MANNER WHATSOEVER WITHOUT FIRST OBTAINING THE EXPRESS WRITTEN PERMISSION AND CONSENT OF W DESIGN, LLC., NOR ARE THEY TO BE ASSIGNED TO ANY THIRD PARTY WITHOUT OBTAINING SAID WRITTEN PERMISSION AND CONSENT. W DESIGN, LLC. IS NOT RESPONSIBLE FOR ANY DISCREPANCY BETWEEN THESE PLANS AND ANY LOCAL CODES AND ORDINANCES HAVING JURISDICTION OVER THE CONSTRUCTION SITE. W DESIGN, LLC. RECOMMENDS THAT THE OWNER OF THESE PLANS HAVE ITHEM REVIEWED BY THE PROPER AUTHORITIES TO DETERMINE IF ANY DISCREPANCIES EXIST AND HAVE ANY NECESSARY CORRECTIONS MADE PRIOR TO CONSTRUCTION.



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CS COVER SHEET

SP SITE PLAN

PT1 FOUNDATION PLAN

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A1 FLOOR PLAN - FIRST FLOOR

A2 FLOOR PLAN - SECOND FLOOR

A3 ELEVATIONS

A4 ELEVATIONS

A5 ROOF PLAN

A6 WALL SECTIONS / EAVE DETAILS

E1 LIGHTING PLAN- FIRST FLOOR

E2 LIGHTING PLAN - SECOND FLOOR

W DESIGN, LLC
608 EAST 3RD STREET
TULSA, OK 74120
918.794.6616
ARCHITECT OF RECORD:
WELDON J. BOWMAN, AIA, NCARB

GENERAL CONTRACTOR CHAD McCUTCHEN HOME INNOVATIONS PH: 918.280.9655

PROJECT TEAM

STRUCTURAL STRESSCON 6533 EAST 11TH STREET TULSA, OK 74112 918.836.0021



Wdesign
ARCHITECTURE & INTERIORS
408 E 3rd Street

608 E. 3rd Street Tulsa, OK 74120 Office: 918.794.6616 Fax: 918.794.6602 www.wdesignsite.com

SEAL:



PROJECT:

SOUZA-LEWIS RESIDENCE ADDITION

> PROJECT # 23163

2736 S. VICTOR AVE. TULSA, OK 74114

CONSULTANT:

REVISIONS

ISSUE DATE:

2.06.2024

SHEET NAME:

COVER SHEET


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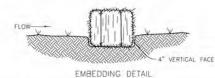
GRADING AND EROSION CONTROL PLAN


- ALL GRADING AND EROSION CONTROL SHALL BE CONSTRUCTED IN ACCORDANCE WITH THE CURRENT CITY STANDARD CONSTRUCTION SPECIFICATIONS.
- ALL EROSION CONTROL CONSTRUCTION SHALL BE INSPECTED BY THE PUBLIC WORKS DEPARTMENT UTILITY INSPECTORS, IN ACCORDANCE WITH CITY POLICY.
- EROSION CONTROL SHALL START WITH INITIAL CONSTRUCTION AND BE PRACTICED THROUGHOUT THE PROJECT.
- HAY BALE DIKES OR SILT FENCES SHALL BE CONSTRUCTED ADJACENT TO ALL DRAINAGE-WAYS, AND IN ALL AREAS THAT WILL ERODE INTO THE STORM SEWER SYSTEM.
- 5. WHERE CONSTRUCTION ACTIVITY TEMPORARILY CEASES FOR 14 DAYS, THE DISTURBED AREAS SHALL BE STABILIZED WITH SEED AND MULCH.
- THE CONTRACTOR SHALL RE-SEED ALL AREAS DISTURBED DURING CONSTRUCTION AND CONTRACTOR SHALL BE RESPONSIBLE FOR SEEDED AREAS UNTIL GROWTH IS ESTABLISHED TO A UNIFORM HEIGHT OF TWO(2) INCHES.
- THERE ARE NO OFFSITE MATERIAL, WASTE, BORROW, OR EQUIPMENT STORAGE AREAS.
- 8. THE STORM WATER POLLUTION PREVENTION PLAN SHALL BE UPDATED AS NECESSARY TO REMAIN CONSISTENT WITH ANY CHANCES APPLICABLE TO PROTECT SURFACE WATER RESOURCES IN SEDIMENT EROSION SITE PLANS OR SITE PERMITS, OR STORM WATER MANAGEMENT SITE PLANS OR SITE PERMITS APPROVED BY STATE OR LOCAL OFFICIALS FOR WHICH THE PERMITBE RECEIVES WRITTEN NOTICE.



- 1. POSTS SHALL BE ANGLED SLIGHTLY TOWARD RUNOFF SOURCE.
- THE TOE OF THE SILT FENCE SHALL BE TRENCHED IN AND BACKFILLED.
- 3. THE TRENCH SHOULD BE 6" DEEP BY 3' TO 4" WIDE TO ALLOW SILT
- 4. SILT FENCE SHALL BE FASTENED TO POSTS OR TO WOVEN WIRE, WHICH IS IN TURN ATTACHED TO THE POSTS.
- 5. INSPECTION SHALL BE FREQUENT AND REPAIR OR REPLACEMENT PROMPT.
- SILT FENCES SHALL BE REMOVED WHEN THEY HAVE SERVED THEIR USEFULNESS SO AS NOT TO IMPEDE STORMWATER FLOW.
- 7. TRAPPED SEDIMENT SHALL BE DISPOSED OF IN AN APPROVED MANNE
- ACCUMULATED SILT SHALL BE REMOVED WHEN IT REACHES A DEPTH OF 6" TO 9" AND DISPOSED OF AS INDICATED IN NOTE 7 ABOVE.


3 SILT FENCE DETAIL

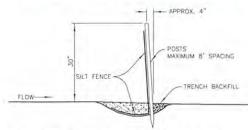

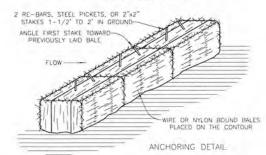

- BALES SHALL BE PLACED IN A ROW WITH ENDS TIGHTLY ABUTTING THE ADJACENT BALES.
- Z EACH BALE SHALL BE EMBEDDED IN THE SOIL A MINIMUM OF FOUR INCHES, WHERE POSSIBLE.
- BALES SHALL BE SECURELY ANCHORED IN PLACE BY STAKES OR RE—BARS DRIVEN THROUGH THE BALES. THE FIRST STAKE IN EACH BALE SHALL BE ANGLED TOWARD PREVIOUSLY LAID BALE TO FORCE BALES TOGETHER.
- 4. INSPECTION SHALL BE FREQUENT AND REPAIR OR REPLACEMEN
- BALES SHALL BE REMOVED WHEN THEY HAVE SERVED THEIR USEFULNESS SO NOT TO BLOCK OR IMPEDE STORM FLOW OR DRAINAGE.
- 6. ACCUMULATED SILT SHALL BE REMOVED WHEN IT REACHES A DEPTH OF 6 INCHES

2 HAY BALE DIKE DETAIL

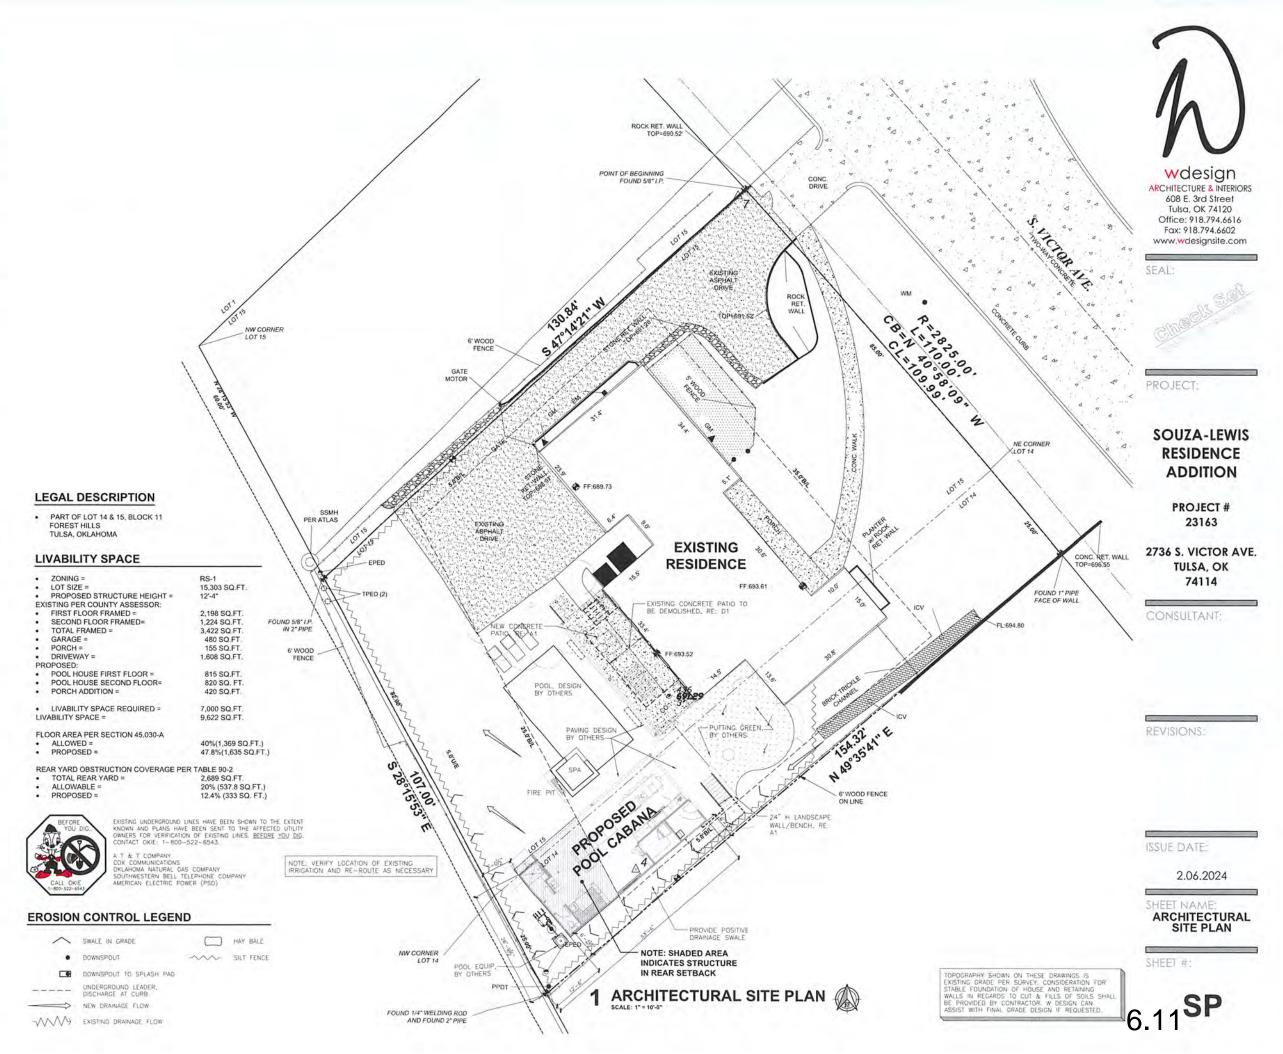

NOTE: ALL PLUMBING WALLS, ARCHED (A.O.), AND CASED OPENING WALLS SHOWN AS 2×4. UNLESS UNTER SHOWN AS 2×4. UNLESS NOTED

NOTE: GARAGE CEILING SHALL BE %" TYPE 'X

NOTE: PEDESTRIAN DOOR FROM CARACE TO RESULENCE SHALL BE 1%" SOLID WOOD DOOR RESULENCE SHOLD WOOD DOOR IRC SECTION 302.5.1

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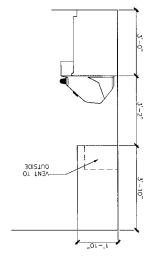
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Sevie: 1/5" = 1'0" HOOD SECTION



MASONRY VENEER WAINSCOT ASONRY VENEER MEW WALL - WOOD STUD SAWBOL DESCRIPTION *TEGEND*

101E: PATIO PAVING BY OTHER THAL DESIGN APPROVED BY WHER.

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AGS

cn

COVERED PORCH

FLOOR PLAN - FIRST FLOOR

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WALL CORD. W/ SCREEN UP EO. RISERS, VARIES W/ FINAL GRADE NOTE: VERIFY AMOUNT OF RISERS
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HANDRAIC SHALL BE INSTALLED
FER IRC SECTION R311.7.8

Office: 918,794,6616 Tulsa, OK 74120 608 E. 3rd 5freet ARCHITECTURE & INTERIORS **u**gisəpm

moo.afizngisabw.www Fox: 918.794.6602

IA

FIRST FLOOR

FLOOR PLAN

2.06.2024

SHEET NAME:

:3TAG BUZZI

BENIZIONZ:

CONSULTANT:

カレレカム

TULSA, OK

2736 S. VICTOR AVE.

23163

PROJECT#

NOITIQ

BEZIDENCE **SOUZA-LEWIS**

PROJECT:

SHEEL #:

COALD BORCH: SOOL HOUSE TOTAL:

(SQUARE FEET)

AREA CALCULATIONS

FOOL HOUSE SECOND FLOOR: 820

POOL HOUSE FIRST FLOOR: 815

LEGEND

SYMBOL	DESCRIPTION
CONTROL OF THE PROPERTY OF THE PARTY.	NEW WALL - WOOD STUD
	MASONRY VENEER
XCD CONTRACTOR CONTRACTOR	MASONRY VENEER WAINSCOT

APPLIANCES INDICATED ON PLANS MAY ONLY BE SCHEMATIC IN NATURE. CONTRACTOR IS RESPONSIBLE FOR VERIFYING INSTALLATION REQUIREMENTS WITH SELECTED APPLIANCES AND PROVIDE NECESSARY CLEARANCES AND CONNECTIONS PER MANUFACTURER'S RECOMMENDATIONS.

FIREPLACE AND HEARTH TO CONFORM TO SECTION 10 OF THE INTERNATIONAL RESIDENTIAL CODE. EVEN THOUGH HEARTH EXTENSION MAY NOT BE SHOWN ON THESE DRAWINGS, HEARTH EXTENSION MAY BE REQUIRED FOR FINAL SELECTION OF FIREPLACE TYPE. CONTRACTOR AND/OR FIREPLACE VENDOR TO VERIFY FINAL SELECTION AND PROVIDE INSTALLATION IN CONFORMANCE WITH THE AFOREMENTIONED CODE SECTION.

R302.7 ENCLOSED ACCESSIBLE SPACE UNDER STAIRS SHALL HAVE WALLS, UNDER STAIR SURFACE AND ANY SOFFITS PROTECTED ON THE ENCLOSED SIDE WITH 1/2" GYPSUM BOARD

EGRESS COMPLIANCE WINDOW, VERIFY WINDOW MANUFACTURER'S GERESS COMPLIANCE SIZE.

= ADJUSTMENTS MAY BE REQUIRED TO ACCOMMODATE WINDOW SELECTION AND STYLE REFER TO IRC 2015, SECTION R310

BASEMENTS, HABITABLE ATTICS AND ALL SLEEPING ROOMS SHALL HAVE NOT LESS THAN ONE EMERGENCY ESCAPE AND RESCUE DEPRING PER SECTION 7310. CONSTRUCTION SHALL BE IN COMPLIANCE WITH SECTION R310.2.1 FOR ALL APPLICABLE OPENINGS PER THIS SECTION.


NOTE: WINDOWS ARE DEFINED AS FEET/INCHES. EX. '2º40' IS MEASURED 2'-0" x 4'-0"

NOTE: PEDESTRIAN DODR FROM GARAGE TO RESIDENCE SHALL BE 1½" SOLID WOOD DOOR AND EQUIPPED WITH SELF-CLOSING DEVICE PER IRC SECTION 302.5.1

NOTE: GARAGE CEILING SHALL BE %" TYPE 'X' GYPSUM BOARD

NOTE: ALL PLUMBING WALLS, ARCHED (A.O.), AND CASED OPENING (C.O.) WALLS ARE SHOWN AS 2x4. REMAINING WALLS SHOWN AS 2x4. UNLESS OTHERWISE NOTED



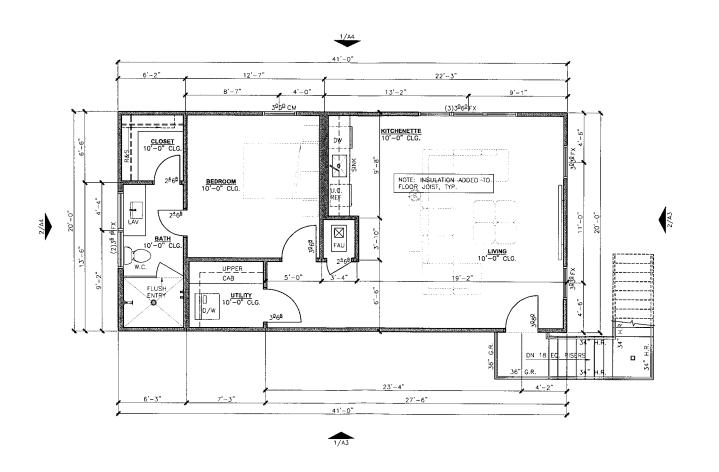



Wdesign
ARCHITECTURE & INTERIORS
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Tulsa, OK 74120
Office: 918.794.6616
Fax: 918.794.6602
www.wdesignsite.com

SEAL:



PROJECT:

SOUZA-LEWIS RESIDENCE ADDITION

PROJECT # 23163

2736 S. VICTOR AVE. TULSA, OK 74114

CONSULTANT:

REVISIONS:

ISSUE DATE:

2.06.2024

SHEET NAME: FLOOR PLAN SECOND FLOOR


SHEET #:

AREA CALCULATIONS (SOUARE FEET)


POOL HOUSE TOTAL:

POOL HOUSE FIRST FLOOR: 815

POOL HOUSE SECOND FLOOR: 820

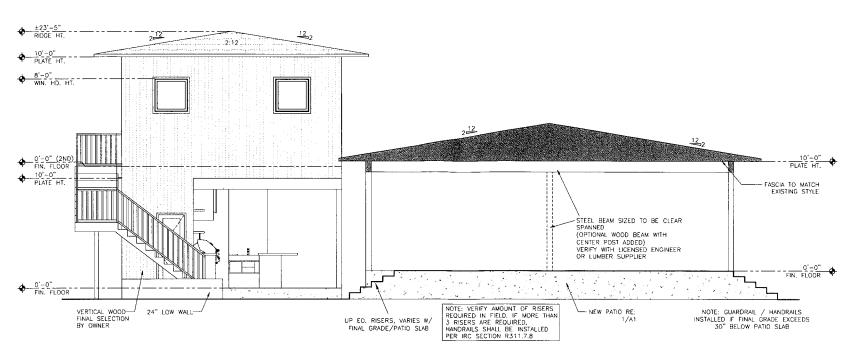

2 LEFT ELEVATION / SECTION @ PORCH

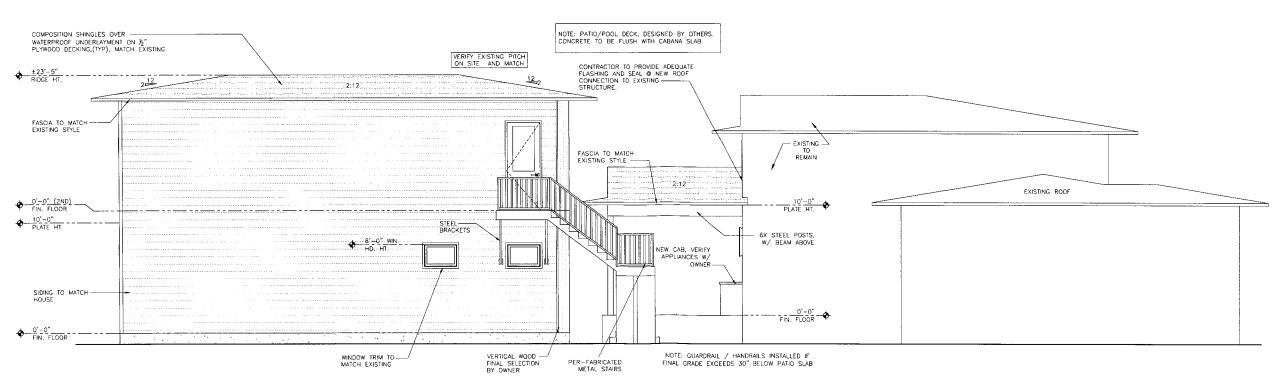

1 REAR ELEVATION

Wdesign
ARCHITECTURE & INTERIORS
608 E. 3rd Street
Tulsa, OK 74120
Office: 918.794.6616
Fax: 918.794.6602
www.wdesignsite.com

SEAL:



PROJECT:

SOUZA-LEWIS RESIDENCE ADDITION

PROJECT # 23163

2736 S. VICTOR AVE. TULSA, OK 74114

CONSULTANT:

REVISIONS:

ISSUE DATE:


2.06.2024


SHEET NAME:

ELEVATIONS

SHEET #:

ELEVATIONS ARE CREATED WITHOUT THE BENEFIT OF A TOPOGRAPHIC SURVEY, CONTRACTOR TO VERIFY IMPACT OF FINAL GRADES TO FOUNDATION/SLAB AND MAKE THE APPROPRIATE ADJUSTMENTS TO FOUNDATION AND/OR VENEER AS NECESSARY TO FACILITATE CONSTRUCTION, STEPS TO GRADE AND GUARD RAILS MAY BE REQUIRED AND MUST CONFORM TO IRC SECTIONS R311 AND R312.

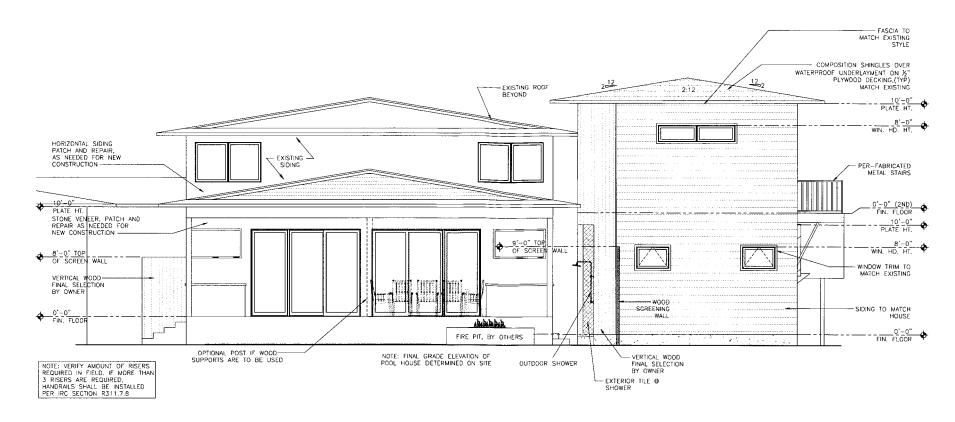

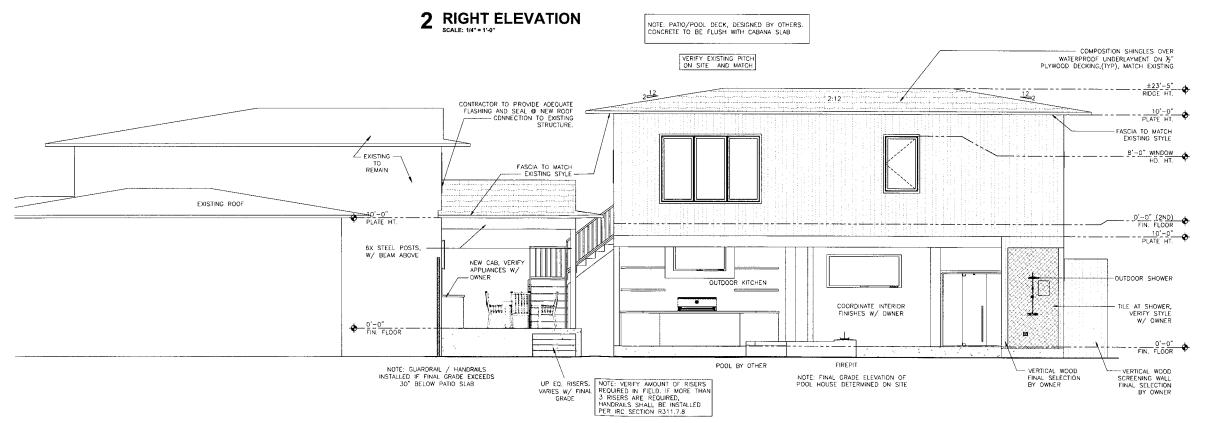

1 FRONT ELEVATION
SCALE: 1/4" = 1'-0"

W

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SEAL:



PROJECT:

SOUZA-LEWIS RESIDENCE ADDITION

PROJECT # 23163

2736 S. VICTOR AVE. TULSA, OK 74114

CONSULTANT:

revisions:

ISSUE DATE:

2.06.2024

SHEET NAME:

ELEVATIONS

SHEET #: